

## • All materials and work practices shall comply with, but not limited to, the Building Regulations 2018, the National Construction Code Series Building Code of Australia Vol 1 & all relevant current Australian Standards (as amended)

residential projects, and all workmanship and precautions shall be to best trade practice.

• Precautions must be taken before and during demolition in accordance with AS 2601-2001: *The Demolition of* 

referred to therein. These specifications specify only the minimum standard of work for the demolition works on


- Structures.
  During the progress of the demolition the works shall be under the continuous supervision of the Demolisher or of an experienced foreman & demolition shall be executed storey by storey commencing at the roof and working downwards.
- The demolition must not be commenced until the precautionary measures have been inspected and approved by the Relevant Authority.
- The Demolisher shall construct a temporary crossing place over the footpath, as required by the Council (if applicable).

   The Demolisher shall construct a temporary crossing place over the footpath, as required by the Council (if applicable).
- No part of any external wall on or within 3M of a street alignment may be pulled down, except during the hours that the Relevant Authority specify.
- the Relevant Authority specify.
  Protective outriggers, fences, awnings, hoarding, barricades and the like must be installed where necessary to guard against danger to life or property or when required by the
- Relevant Authority.

   Dust creating material (unless thoroughly dampened down) shall not be thrown or dropped from the building but shall be lowered by hoisting apparatus or removed by material chutes. All chutes shall be completely enclosed and a
- danger sign shall be at the discharge end of every chute.
   All practicable precautions shall be taken to avoid danger from collapse of a building when any part of a framed or
- partly framed building is removed.
  Demolished material shall not be allowed to remain on any floor or structure if the weight of the material exceeds the safe carrying capacity of the floor or structure, and such material shall not be so piled or stacked that it will endanger workmen or other persons, and shall be removed as soon as practicable from the site.
- No wall, chimney or other structure or part of a structure shall be left unattended or unsupported in such a condition that it may collapse due to wind or vibration or other-wise become dangerous.
- Before demolition is commenced (and also during the progress of such works) all electrical cable or apparatus which are liable to be a source of danger (other than cable or apparatus used for the demolition works) shall be disconnected.
- Arrangements shall be made with the Relevant Electrical Supply Authority for the disconnection of electrical mains supply except that, where partial demolition is proposed, the licensed Electrical Contractor shall satisfy the Relevant Electrical Supply Authority that the portion of the building to
- be demolished has been isolated.
  The Demolisher shall be responsible for the disconnection of
- all telecommunication supplies.
  The Demolisher shall be responsible to cut and seal any storm water, sewer pipes, water services, gas services and the like.
- The position of capped sewer and storm water drains, sealed-off water supply lines, gas supply lines and

filled with clean sand.

- the like are to be clearly marked on the site.
  Any septic tank(s) on the demolition site shall be emptied and filled with clean sand, or removed entirely, and any soak wells, leach drains or similar apparatus shall be removed or
- Materials removed or displaced from the building shall not be placed in any street, road or right of way and, before commencement (where required) shall be kept sprayed with
- water so as to prevent any nuisance from dust.
  Materials removed or displaced from the building being demolished or materials left standing shall not be burned on
- the demolition site.
  Removal of buildings by road must be approved by Relevar Councils Traffic Engineer.
- A Site Management Plan is to be implemented during demolition works to control sediment run-off in accordance with the relevant State EPA requirements. Where required provide 'propex' or equivalent silt fences to the low side of the allotment and around all soil stockpiles and storm water inlet pits/sumps and install 'silt stop' filter bags over all storm water entry pits during demolition works. 'Supergro' or equivalent erosion control fabric to be placed over garden beds to prevent surface erosion during re-vegetation period.
- It is the Builder's responsibility to carry out an audit prior to the commencement of any works to determine if asbestos is present in the existing works. Where any asbestos product is found in the proposed works area during initial inspection or during the course of the demolition works the builder shall engage an authorised and registered contractor for safe removal and lawful disposal.

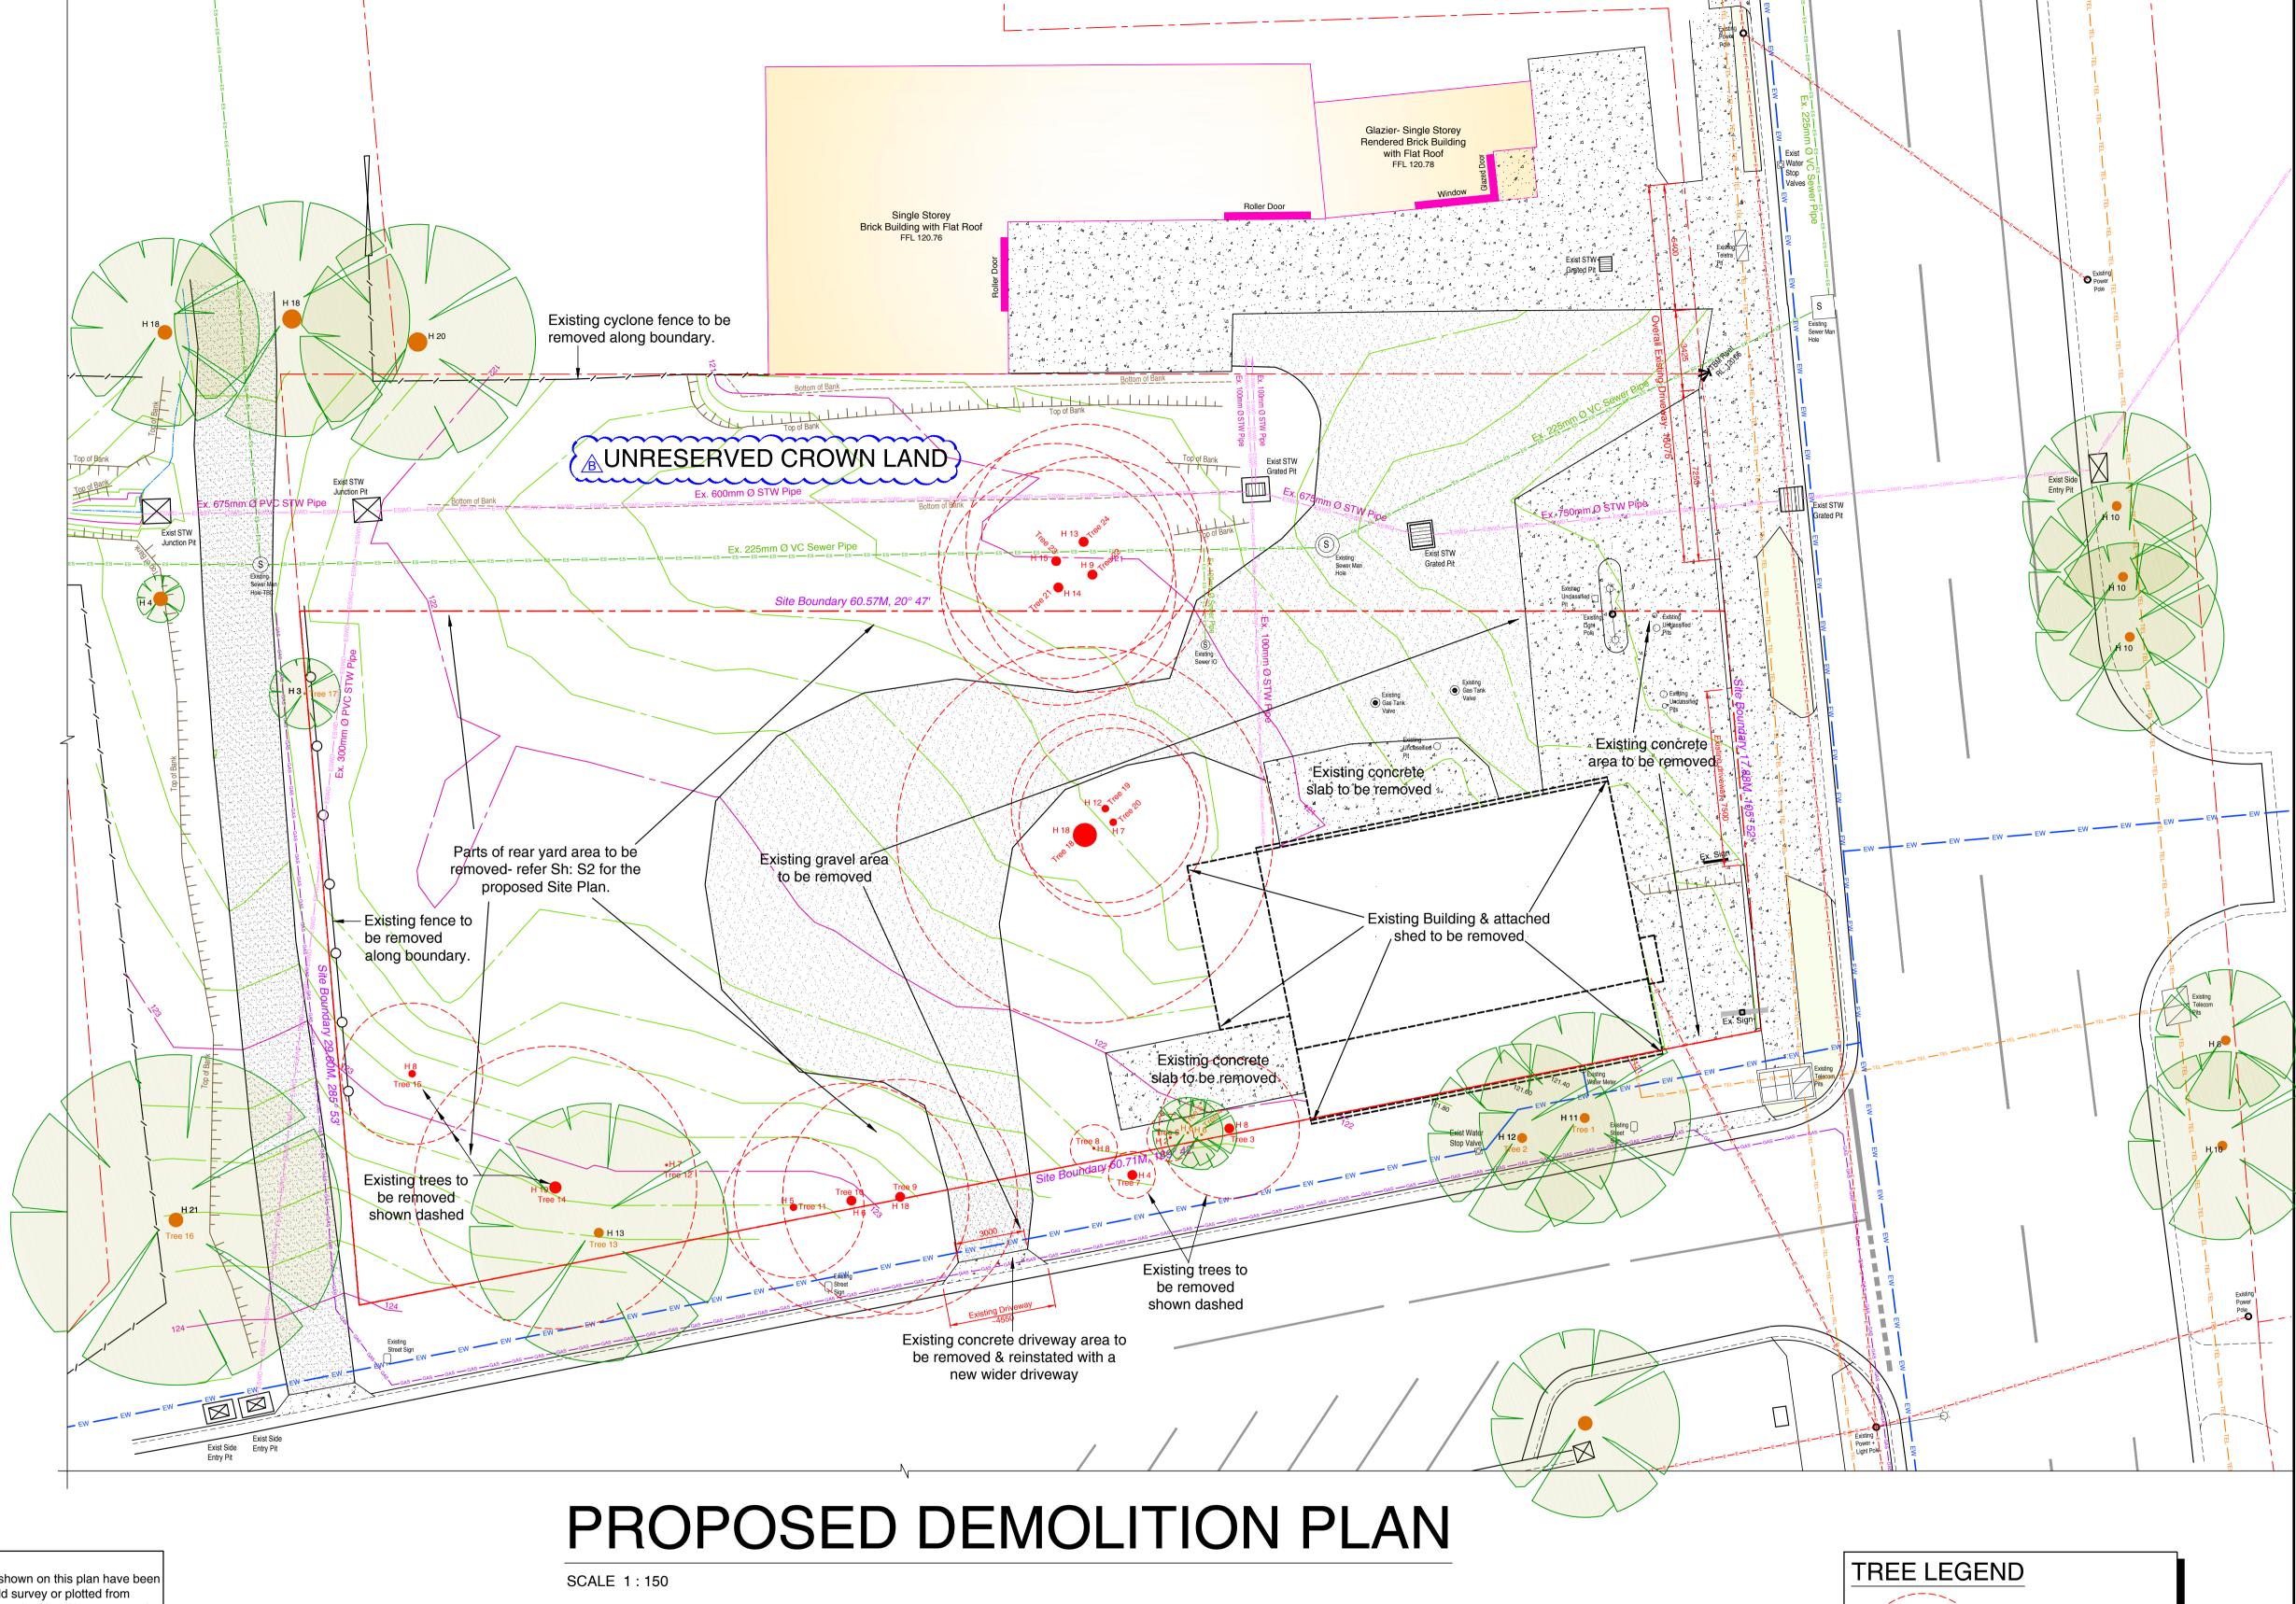

## SERVICES LEGEND

Existing Above Ground Power

GAS — GAS — GAS — Existing Gas Mains

Existing Water Mains Pipe

TEL — TEL — TEL — Existing Telstra/NBN Cables

— ES — ES — ES — Existing Sewer Pipe

WARNING:
The existing services shown on this plan have been derived either from field survey or plotted from records of the relevant authorities. No guarantee is given as to their accuracy. It is the responsibility of the contractor to verify on site the location of all services prior to the commencement of works.

DIAL BEFORE
YOU DIG
www.1100.com.au

PRELIMINARY DRAWING AT: 2420 WARB

В	'Drainage Reserve' re-named to 'Unreserved Crown Land'- Plan updated	22-07-20
Α	Issued For Council Planning Approval	21-04-20
ISSUE	DESCRIPTION	DAT
REVISIONS		

**Existing Stormwater Pipe** 

© TMC Building Design Group 2022
© Design Copyright
These drawings may not be copied in whole or in part without the written consent of TMC Building Design Group. Any changes proposed by the Client, Council or the relevant Planning Approval Authority shall be reported to TMC Building Design Group authorisation prior to said changes being



PROPOSED FUEL & CAR WASH DEVELOPMENT

AT: 2420 WARBURTON HIGHWAY, YARRA JUNCTION, VIC, 3797.

FOR: ECO WASH AUSTRALIA PTY LTD

T. MICHAELS

T. MICHAELS

4.
Design Matters
National
The peak body for the building design profession
Member

TMC | Building Design Group

P.O. Box 3494, Mornington, VIC, 3931. Phone No. 0416 114 573

E:mail- tracey@tmcdesign.com.au

Scale: 1:100 (A1) Date: JULY 2022 Issue:

Sheet No: 6 of 7. Job No: 21-037 TF

Indicates extent of existing tree

Tree #- Arborist Tree Number

Extent of existing tree canopy

to be removed

H#- Height of the tree

implemented.

TC 22 July 2022 5:05 PM - T:\TMC\\2021\21-037 Robert Pacel- Yarra Junction, VIC\21-037 TP Rev B.dwg

NOT TO BE USED FOR CONSTRUCTION PURPOSES

